GREEN TREE EAST LEADERSHIP ACADEMY PARKING LOT SLURRY SEAL AND PLAYGROUND RESURFACING

VICTOR ELEMENTARY SCHOOL DISTRICT

17246 GIBRALTER DR.

VICTORVILLE, CA 92395

	GENERAL NOTES		GOVERNING	G CODES	SHEET INDE	X PROJECT TEAM
HESE DRAWINGS DO NOT CONTAIN THE NECESSARY COMPONENTS FOR CONSTRUCTION SAFETY. OCATIONS OF ALL UTILITIES SHOWN ARE APPROXIMATE AND CONTRACTOR SHALL EXERCISE EXTREME CAUTION IN EXCAVATION AND TRENCHING ON THIS SITE TO AVOID INTERCEPTING EXISTING PIPING AND CONDUITS. IT SHALL BE THE RESPONSIBILITY OF THE CONTRACTOR TO LOCATE ALL EXISTING UTILITIES WHETHER SHOWN HEREON OR NOT AND TO PROTECT THEM FROM DAMAGE. THE ARCHITECT IS NOT RESPONSIBLE FOR THE LOCATION OF UNDERGROUND UTILITIES OR STRUCTURES WHETHER OR NOT SHOWN OR DETAILED AND INSTALLED BY ANY OTHER CONTRACT. THE CONTRACTOR SHALL IMMEDIATELY NOTIFY THE ARCHITECT SHOULD ANY UNIDENTIFIED CONDITIONS BE DISCOVERED. THE CONTRACTOR SHALL IMMEDIATELY NOTIFY THE ARCHITECT SHOULD ANY UNIDENTIFIED CONDITIONS BE DISCOVERED. THE CONTRACTOR SHALL BEAR ALL EXPENSES OF REPAIR OR REPLACEMENT OF UTILITIES OR OTHER PROPERTY DAMAGED BY OPERATIONS IN CONJUNCTION WITH THE PROSECUTION OF THIS WORK. HESE DOCUMENTS AND THE IDEAS AND DESIGNS INCORPORATED HEREIN, AS AN INSTUMENT OF SERVICE, ARE THE PROPERTY OF PBK ARCHITECTS, INC., AND ARE NOT TO BE USED, IN WHOLE OR IN PART, FOR ANY OTHER PROJECT WITHOUT THE WRITTEN AUTHORIZATION OF PBK ARCHITECTS, INC., AND ARE NOT TO BE USED, IN WHOLE OR IN PART, FOR ANY OTHER PROJECT WITHOUT THE WRITTEN AUTHORIZATION OF PBK ARCHITECTS, INC., IN NOT RESPONSIBLE FOR THE ACCURACY OR ADEQUACY OF ANY WORK SHOWN AS EXISTING CONDITIONS WAS PREPARED FROM INFORMATION FURNISHED BY THE OWNER. WHILE THIS INFORMATION IS BELIEVED TO BE RELIABLE, PBK ARCHITECTS, INC. IS NOT RESPONSIBLE FOR THE ACCURACY OR ADEQUACY OF ANY WORK SHOWN AS EXISTING NOR IS PBK ARCHITECTS, INC. RESPONSIBLE FOR ANY EXPENSIVE FOR THE ACCURACY OR ADEQUACY OF ANY WORK SHOWN AS EXISTING NOR IS PBK ARCHITECTS, INC. RESPONSIBLE FOR ANY EXERCISE FOR THE ACCURACY OR ADEQUACY OF ANY WORK SHOWN AS EXISTING FOR THE PURPOSE OF FIRE FIRE SAFETY DURING CONSTRUCTION SHALL COMPLY WITH CALIFORNIA FIRE CODE (CFC) CALIFORNIA CODE OF REGULATIONS (CCR) TITLE 24, PART 9, CHAPTER 33. C. WATER SUPPLY: WATER	 6. INSPECTOR OF RECORD REQIUREMENTS: A. DSA ACCESS REVIEW ONLY PROJECT LO.R. NOT REQUIRED. 7. ALL WORK SHALL CONFORM TO TITLE 24, CALIFORNIA CODE OF REGULATIONS (CCR). 9. CHANGES MADE TO THE APPROVED DRAWINGS AND SPECIFICATIONS SHALL BE MADE BY AN ADDENDUM OR A CONSTRUCTION CHANGE DOCUMENT (CCD) APPROVED BY THE DIVISION OF THE STATE ARCHITECT, AS REQUIRED BY TITLE 24, CCR, PART 1, SECTION 4-338. 10. SOIL BEARING PRESSURE ASSUMED AT: 1,500 PSF PER CBC TABLE 1806A 2, ITEM 5. 11. A DSA ACCEPTED TESTING LABORATORY DIRECTLY EMPLOYED BY THE DISTRICT(OWNER) SHALL CONDUCT ALL THE REQUIRED TESTS AND INSPECTIONS FOR THE PROJECT. 12. PATH OF TRAVEL (POT) AS INDICATED IS A BARRIER FREE ACCESS ROUTE WITHOUT ANY ABRIPT VERTICAL CHANGES EXCEEDING 1/2" BEVELED AT 12 MAXIMUM SLOPE, EXCEPT THAT LEVEL CHANGES DO NOT EXCEED 1/4" VERTICAL AND IS AT LEAST 4-0" WIDE. SURFACE IS SUP RESISTANT STABLE, FIRM AND SMOOTH, MAXIMUM CROSS-SLOPE IS 2% TYPICAL AND SLOPE IN THE DIRECTION OF TRAVEL IS LESS THAN 3%. PATH OF TRAVEL SHALL BE MAINTAINED FREE OF OVERHANGING DISTRUCTIONS TO 6'-8" MINIMUM AND PROTRUDING OBJECTS GREATER THAN 4" PROJECTION FROM WALL BETWEEN 2-3" AND 6-8" ABOVE SURFACE OF PATH OF TRAVEL. CONTRACTOR SHALL VERIFY THAT ALL BARRIERS ON THE INDICATED PATH OF TRAVEL HAVE BEEN REMOVED AND PATH OF TRAVEL CONTRACTOR SHALL VERIFY THAT ALL BARRIERS ON THE INDICATED PATH OF TRAVEL HAVE BEEN REMOVED AND PATH OF TRAVEL COMPLIES WITH CGC SECTION 118-206. 13. GRATINGS LOCATED IN THE SURFACE OF ANY PEDESTRIAN WAY IN THE PATH OF TRAVEL SHALL HAVE GETON OF TRAFFIC FLOW. IF SUCH CONDITION OCCURS, MANUFACTURERS CUT-SHEETS WILL BE PROVIDED FOR REVIEW. 14. GATES IN THE PATH OF TRAVEL MUST COMPLY WITH EXIT DOOR REQUIREMENTS OF CALIFORNIA BUILDING CODE (CGC) SECTION 1003.3.1. GATES WILL BE PROVIDED WITH A MINIMUM MEDIUM BROOM NON-SLIP FINISH. 15. ALL NEW CONCRETE PAVING WITH A SLOPE GREATER THAN 6% SHALL BE PROVIDED WIT	18. THE INTENT OF THESE DRAWINGS AND SPECIFICATIONS IS THAT THE WORK OF THE ADDITION, ALTERATION OR RECONSTRUCTION IS IN COMPLIANCE WITH THE REQUIREMENTS OF ITILE 24, CALIFORNIA CODE OF REGULATIONS. SHOULD ANY CONDITIONS SUCHED WHICH IS NOT IDENTIFIED BY THE CONTRACT DOCUMENTS WHEREIN THE FINAL WORK WOULD NOT COMPLY WITH THE REQUIREMENTS OF ITILE 24, CALIFORNIA CODE OF REGULATIONS, THE CONTRACTOR SHALL IMMEDIATELY NOTIFY THE OWNER AND THE ARCHITECT OF THE CONDITION IN WRITING. NECESSARY INFORMATION REQUIRED TO CORRECT THE CONDITIONS ENCOUNTERED WILL BE ISSUED BY THE ARCHITECT. A CCD MAY BE ISSUED TO ADJUST THE CONTRACT SUM OR TIME COMMENSURATE WITH THE AMOUNT OF ADDITIONAL WORK REQUIRED IS ANY. THE CCD SHALL BE APPROVED BY THE DIVISION OF THE STATE ARCHITECT PRIOR TO PROCEEDING WITH THE WORK REQUIRED BY THE CHANGE ORDER. 19. GRADING PLANS, DRAINAGE IMPROVEMENTS, ROAD AND ACCESS REQUIREMENTS AND ENVIRONMENTAL HEALTH CONSIDERATIONS SHALL COMPLY WITH ALL LOCAL ORDINANCES.	2022 CALIFORNIA BUILDING STANDARDS ADMINISTRATIVE CODE CALIFORNIA CODE OF REGULATIONS (CCR) TITLE 24, PART 1 2022 CALIFORNIA BUILDING CODE (CBC) CALIFORNIA CODE OF REGULATIONS (CCR) TITLE 24, PART 2 2022 CALIFORNIA ELECTRICAL CODE (CEC) CALIFORNIA CODE OF REGULATIONS (CCR) TITLE 24, PART 3 2022 CALIFORNIA MECHANICAL CODE (CMC) CALIFORNIA CODE OF REGULATIONS (CCR) TITLE 24, PART 4 2022 CALIFORNIA PLUMBING CODE (CPC) CALIFORNIA CODE OF REGULATIONS (CCR) TITLE 24, PART 5 2022 CALIFORNIA ENERGY CODE CALIFORNIA CODE OF REGULATIONS (CCR) TITLE 24, PART 6 2022 CALIFORNIA HISTORICAL BUILDING CODE CALIFORNIA CODE OF REGULATIONS (CCR) TITLE 24, PART 8 2022 CALIFORNIA FIRE CODE (CFC) CALIFORNIA CODE OF REGULATIONS (CCR) TITLE 24, PART 9 2022 CALIFORNIA FIRE CODE (CFC) CALIFORNIA CODE OF REGULATIONS (CCR) TITLE 24, PART 10 2022 CALIFORNIA EXISTING BUILDING CODE CALIFORNIA CODE OF REGULATIONS (CCR) TITLE 24, PART 10 2022 CALIFORNIA FIRE CODE (CFC) CALIFORNIA CODE OF REGULATIONS (CCR) TITLE 24, PART 11 2022 CALIFORNIA REFERENCED STANDARDS CODE (CAL GREEN) CALIFORNIA CODE OF REGULATIONS (CCR) TITLE 24, PART 11 2022 CALIFORNIA REFERENCED STANDARDS CODE -CALIFORNIA CODE OF REGULATIONS (CCR) TITLE 24, PART 11 2022 CALIFORNIA REFERENCED STANDARDS CODE -CALIFORNIA CODE OF REGULATIONS (CCR) TITLE 24, PART 12 CALIFORNIA CODE OF REGULATIONS (CCR) TITLE 24, PART 12 CALIFORNIA CODE OF REGULATIONS (CCR) TITLE 24, PART 12 CALIFORNIA CODE OF REGULATIONS (CCR) TITLE 24, PART 12 CALIFORNIA CODE OF REGULATIONS (CCR) TITLE 24, PART 12 CALIFORNIA CODE OF REGULATIONS (CCR) TITLE 24, PART 12 CALIFORNIA CODE OF REGULATIONS (CCR) TITLE 24, PART 12 CALIFORNIA CODE OF REGULATIONS (CCR) TITLE 24, PART 12 CALIFORNIA CODE OF REGULATIONS (CCR) TITLE 24, PART 12 CALIFORNIA CODE OF REGULATIONS (CCR) TITLE 24, PART 12 CALIFORNIA CODE OF REGULATIONS (CCR) TITLE 24, PART 12 CALIFORNIA CODE OF REGULATIONS (CCR) TITLE 24, PART 12 CALIFORNIA CODE OF REGULATIONS (CCR) TITLE 24, PART 15 CODE OF REGULATIONS (CCR) TITLE 24, PART 19 2010 A	CODE (UMC) W/ CALIFORNIA AMENDMENTS) (2021 UNIFORM PLUMBING CODE (UPC) W/ CALIFORNIA AMENDMENTS) (2021 INTERNATIONAL FIRE CODE (IFC) W/ CALIFORNIA AMENDMENTS) (2021 INTERNATIONAL EXISTING BUILDING CODE (IEBC) W/ CALIFORNIA AMENDMENTS) 1990 STATE FIRE MARSHAL REGULATIONS (AS AMENDED TO DATE) CALIFORNIA CODE OF REGULATIONS (CCR) TITLE 19	DRAWING REF NO ARCHITECTURAL A0.1 GENERAL NOTES / PROJECT DIRE A1.0 OVERALL SITE PLAN A1.1 ENLARGED SITE PLAN A1.2 ENLARGED SITE PLAN A1.3 ENLARGED SITE PLAN A1.4 DETAILS A1.5 DETAILS TOTAL NU	GREEN TREE EAST LEADERSHIP ACADEMY 17246 GIBRALTER DR.,
RAFTING SYMBOL LEGE	END & ABBREVIATIONS		GOVERNING	AGENCIES	SCOPE OF WOR	RK VICINITY MAP
DETAIL 10 = DETAIL DESIGNATION 8.3 = REFERENCE DRAWING NUMBER 10 10 8.3	ABBREVIATIONS AND MISC MISCELLANEOUS AT NA NOT APPLICABLE CENTERLINE NTS NOT TO SCALE EXISTING O/ OVER		DIVISION OF THE STATE ARCHITECT ACCESS COMPLIANCE (DSA/AC) 10920 VIA FRONTERA, SUITE 300 SAN DIEGO, CA 92127		THE SCOPE OF THE WORK AS STATED BELOW IS FOR DSA F PURPOSES ONLY AND DOES NOT CONSTITUTE A DETAILED EXPLANATION OF THE REQUIREMENTS OF THE CONTRACT I PARKING LOT SLURRY SEAL, STRIPING, PLAYGROUND EQUI	AND FULL DOCUMENTS. 17246., GIBRALTER DR., CA 92395

ON CENTER(S) OFCI OWNER FURNISHED -

SCHEDULE

STANDARD

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CLEAR(ANCE)

DEMOLISH, DEMOLITION

EXPANSION JOINT

3 = REVISION NUMBER

REFERENCE NOTE

CENTER LINES, FLOOR LINES

LINES AND MATCH LINES

AND LEVEL LINES

PROPERTY LINES, BOUNDRY


———— SECTION LINES


CONTRACTOR INSTALLED


OWNER FURNISHED -

OWNER INSTALLED



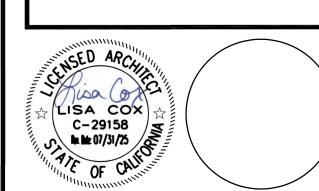

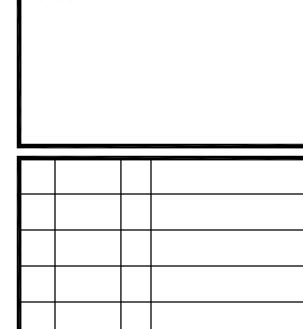


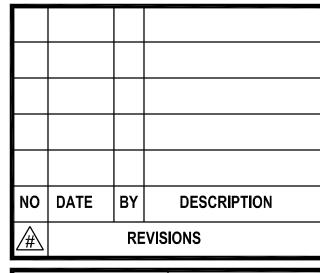

CHECKED: PBK DRAWN: IS **DATE**: 02/24/2023 **SCALE**: PROJECT NUMBER: 2011200

> GENERAL NOTES & PROJECT DIRECTORY

DRAWING Number:

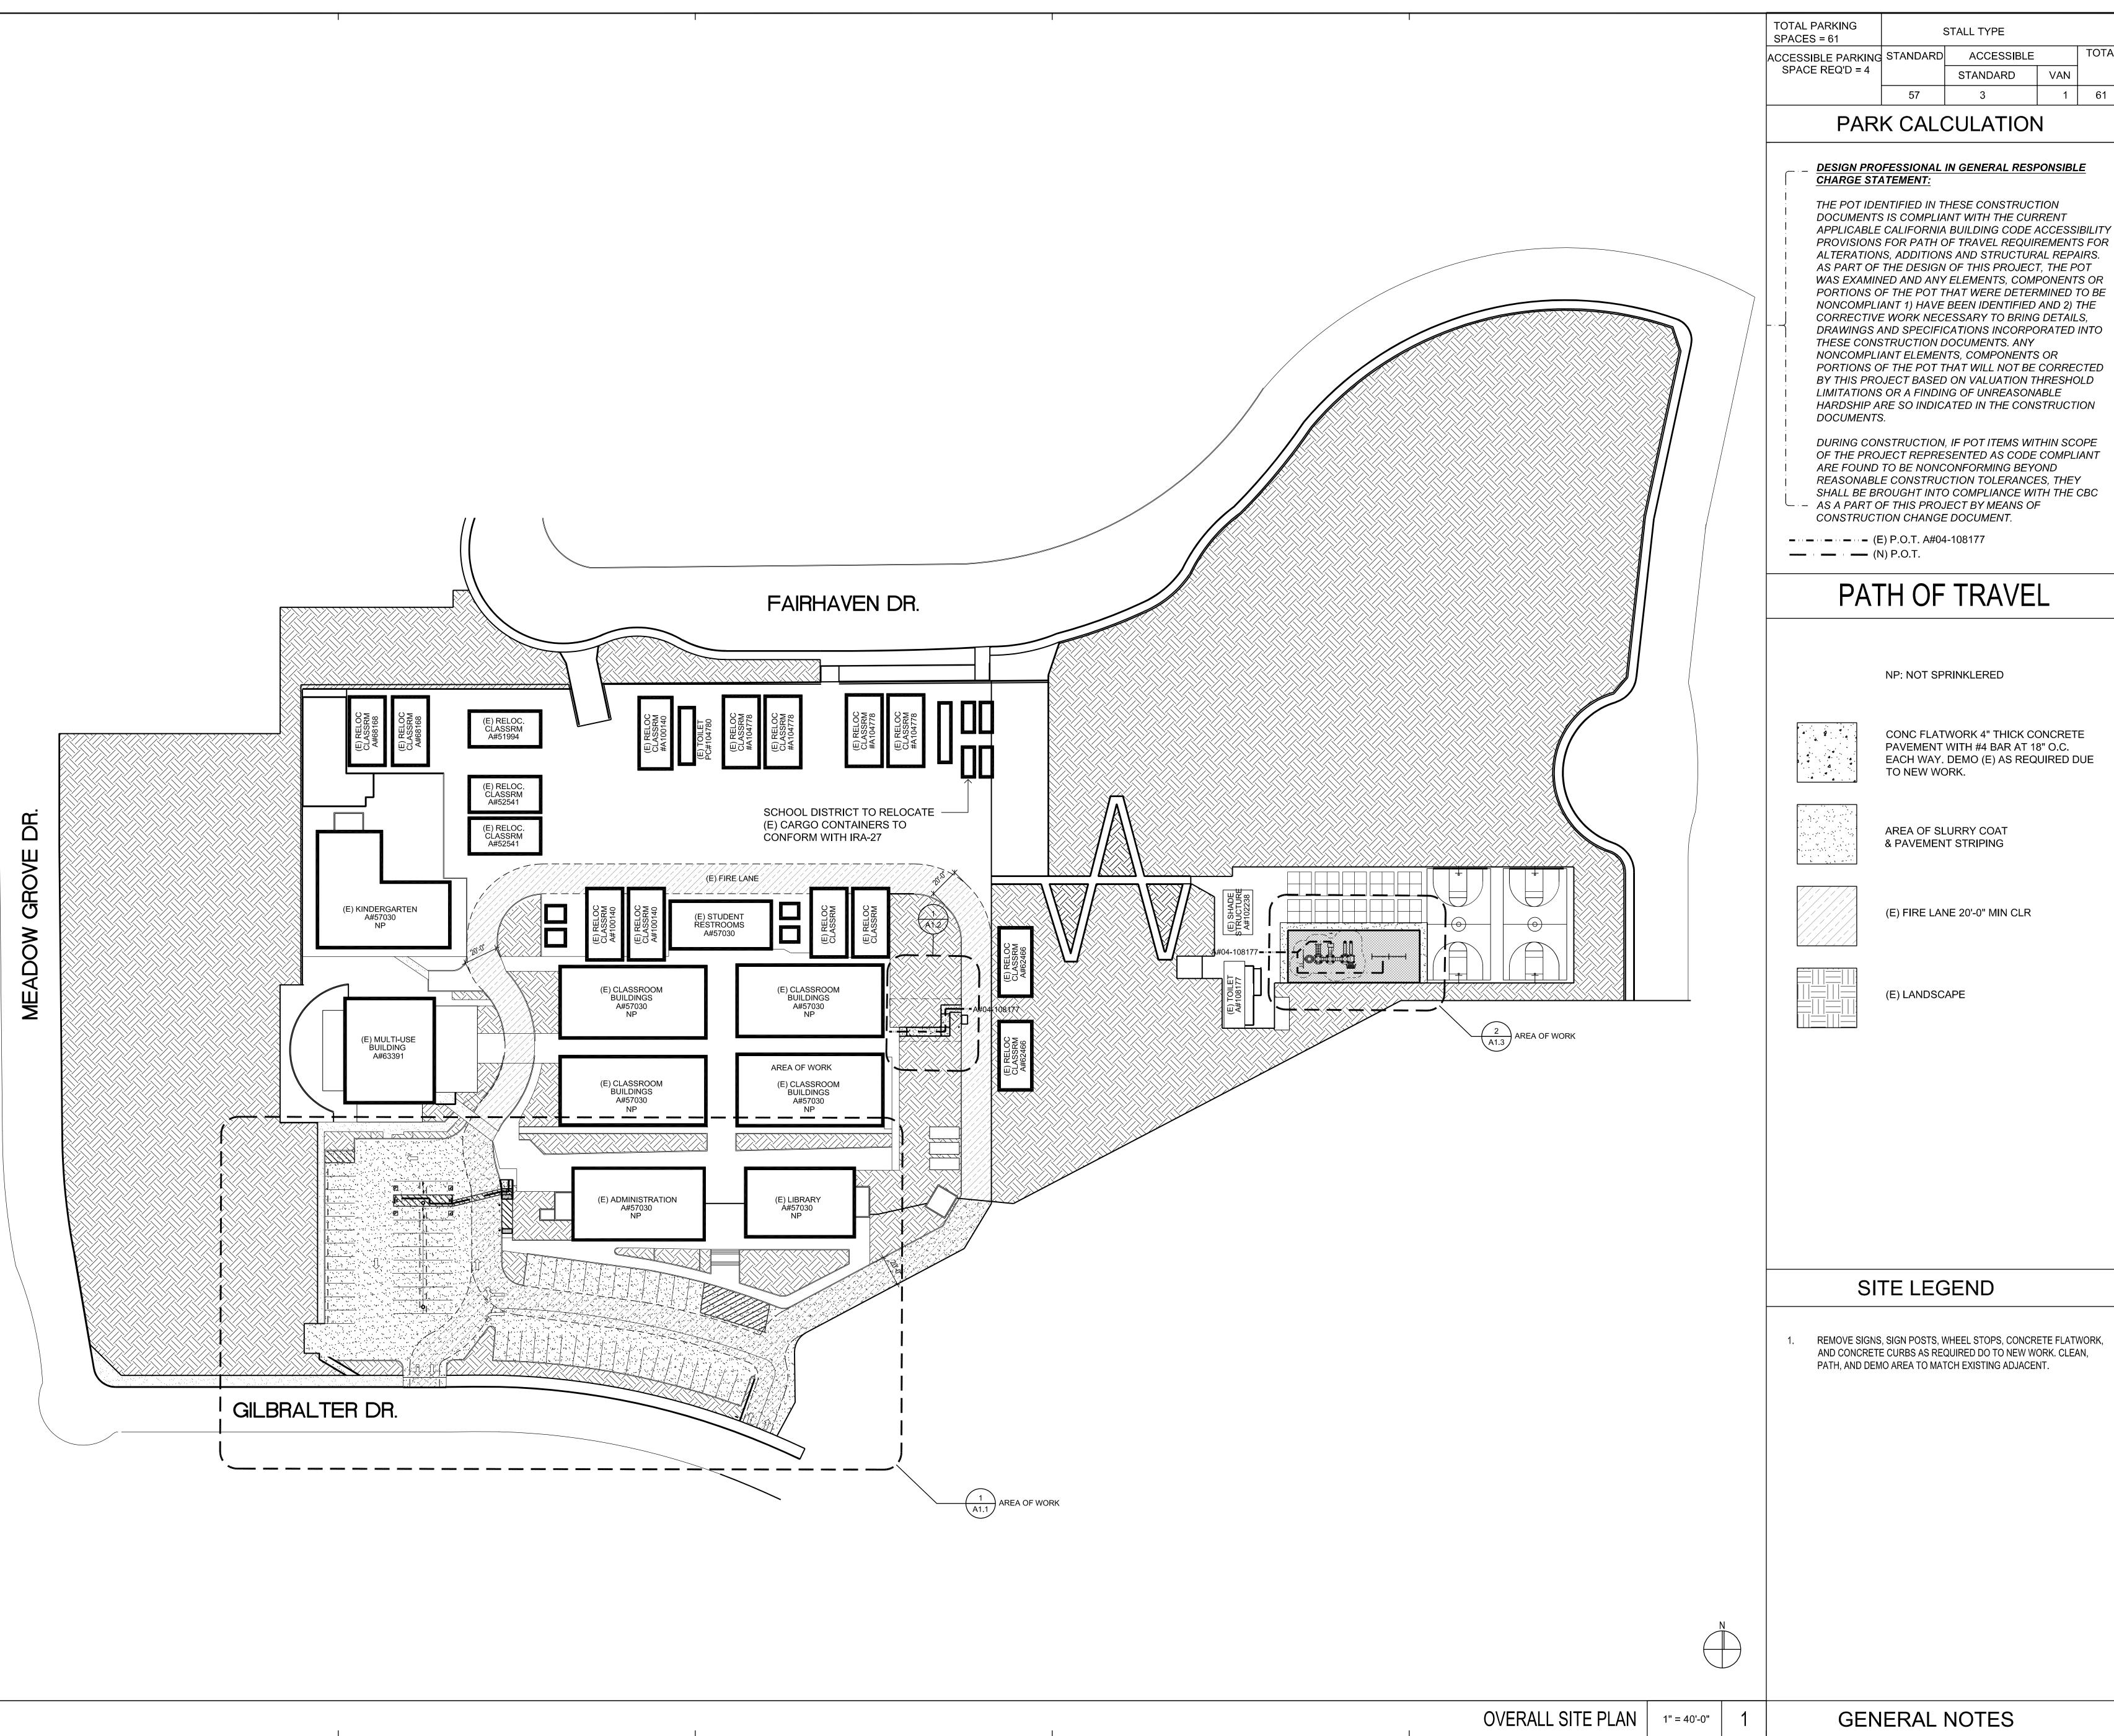

STALL TYPE IDENTIFICATION STAMP DIV. OF THE STATE ARCHITECT TOTAL ACCESSIBLE STANDARD APP: 04-122248 INC: VAN REVIEWED FOR SS ☐ FLS ☐ ACS ☑ DATE: 08/18/2023



RANCHO CUCAMONGA

8163 ROCHESTER AVENUE, SUITE 100 RANCHO CUCAMONGA, ĆA 91730 909-987-0909 P

CING

ADERSHIP ACADEMY
D PLAYGROUND RESURFA
Y SCHOOL DISTRICT
ALTER DR.
E, CA 92395

AREA OF SLURRY COAT & PAVEMENT STRIPING

(E) LANDSCAPE

LISA COX C-29158

LISA COX C-29158

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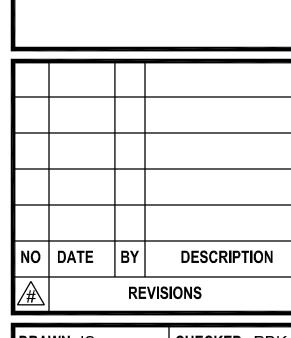
COX C-29158 CONSULTANT

GREEN TREE F
LOT SLURRY S
VICTOR E

ARKING

SITE LEGEND

REMOVE SIGNS, SIGN POSTS, WHEEL STOPS, CONCRETE FLATWORK, AND CONCRETE CURBS AS REQUIRED DO TO NEW WORK. CLEAN, PATH, AND DEMO AREA TO MATCH EXISTING ADJACENT.




DRAWN: IS CHECKED: PBK **DATE**: 02/24/2023 **SCALE**: PROJECT NUMBER: 2011200


> OVERALL SITE PLAN

DRAWING Number:

A1.0

GENERAL NOTES

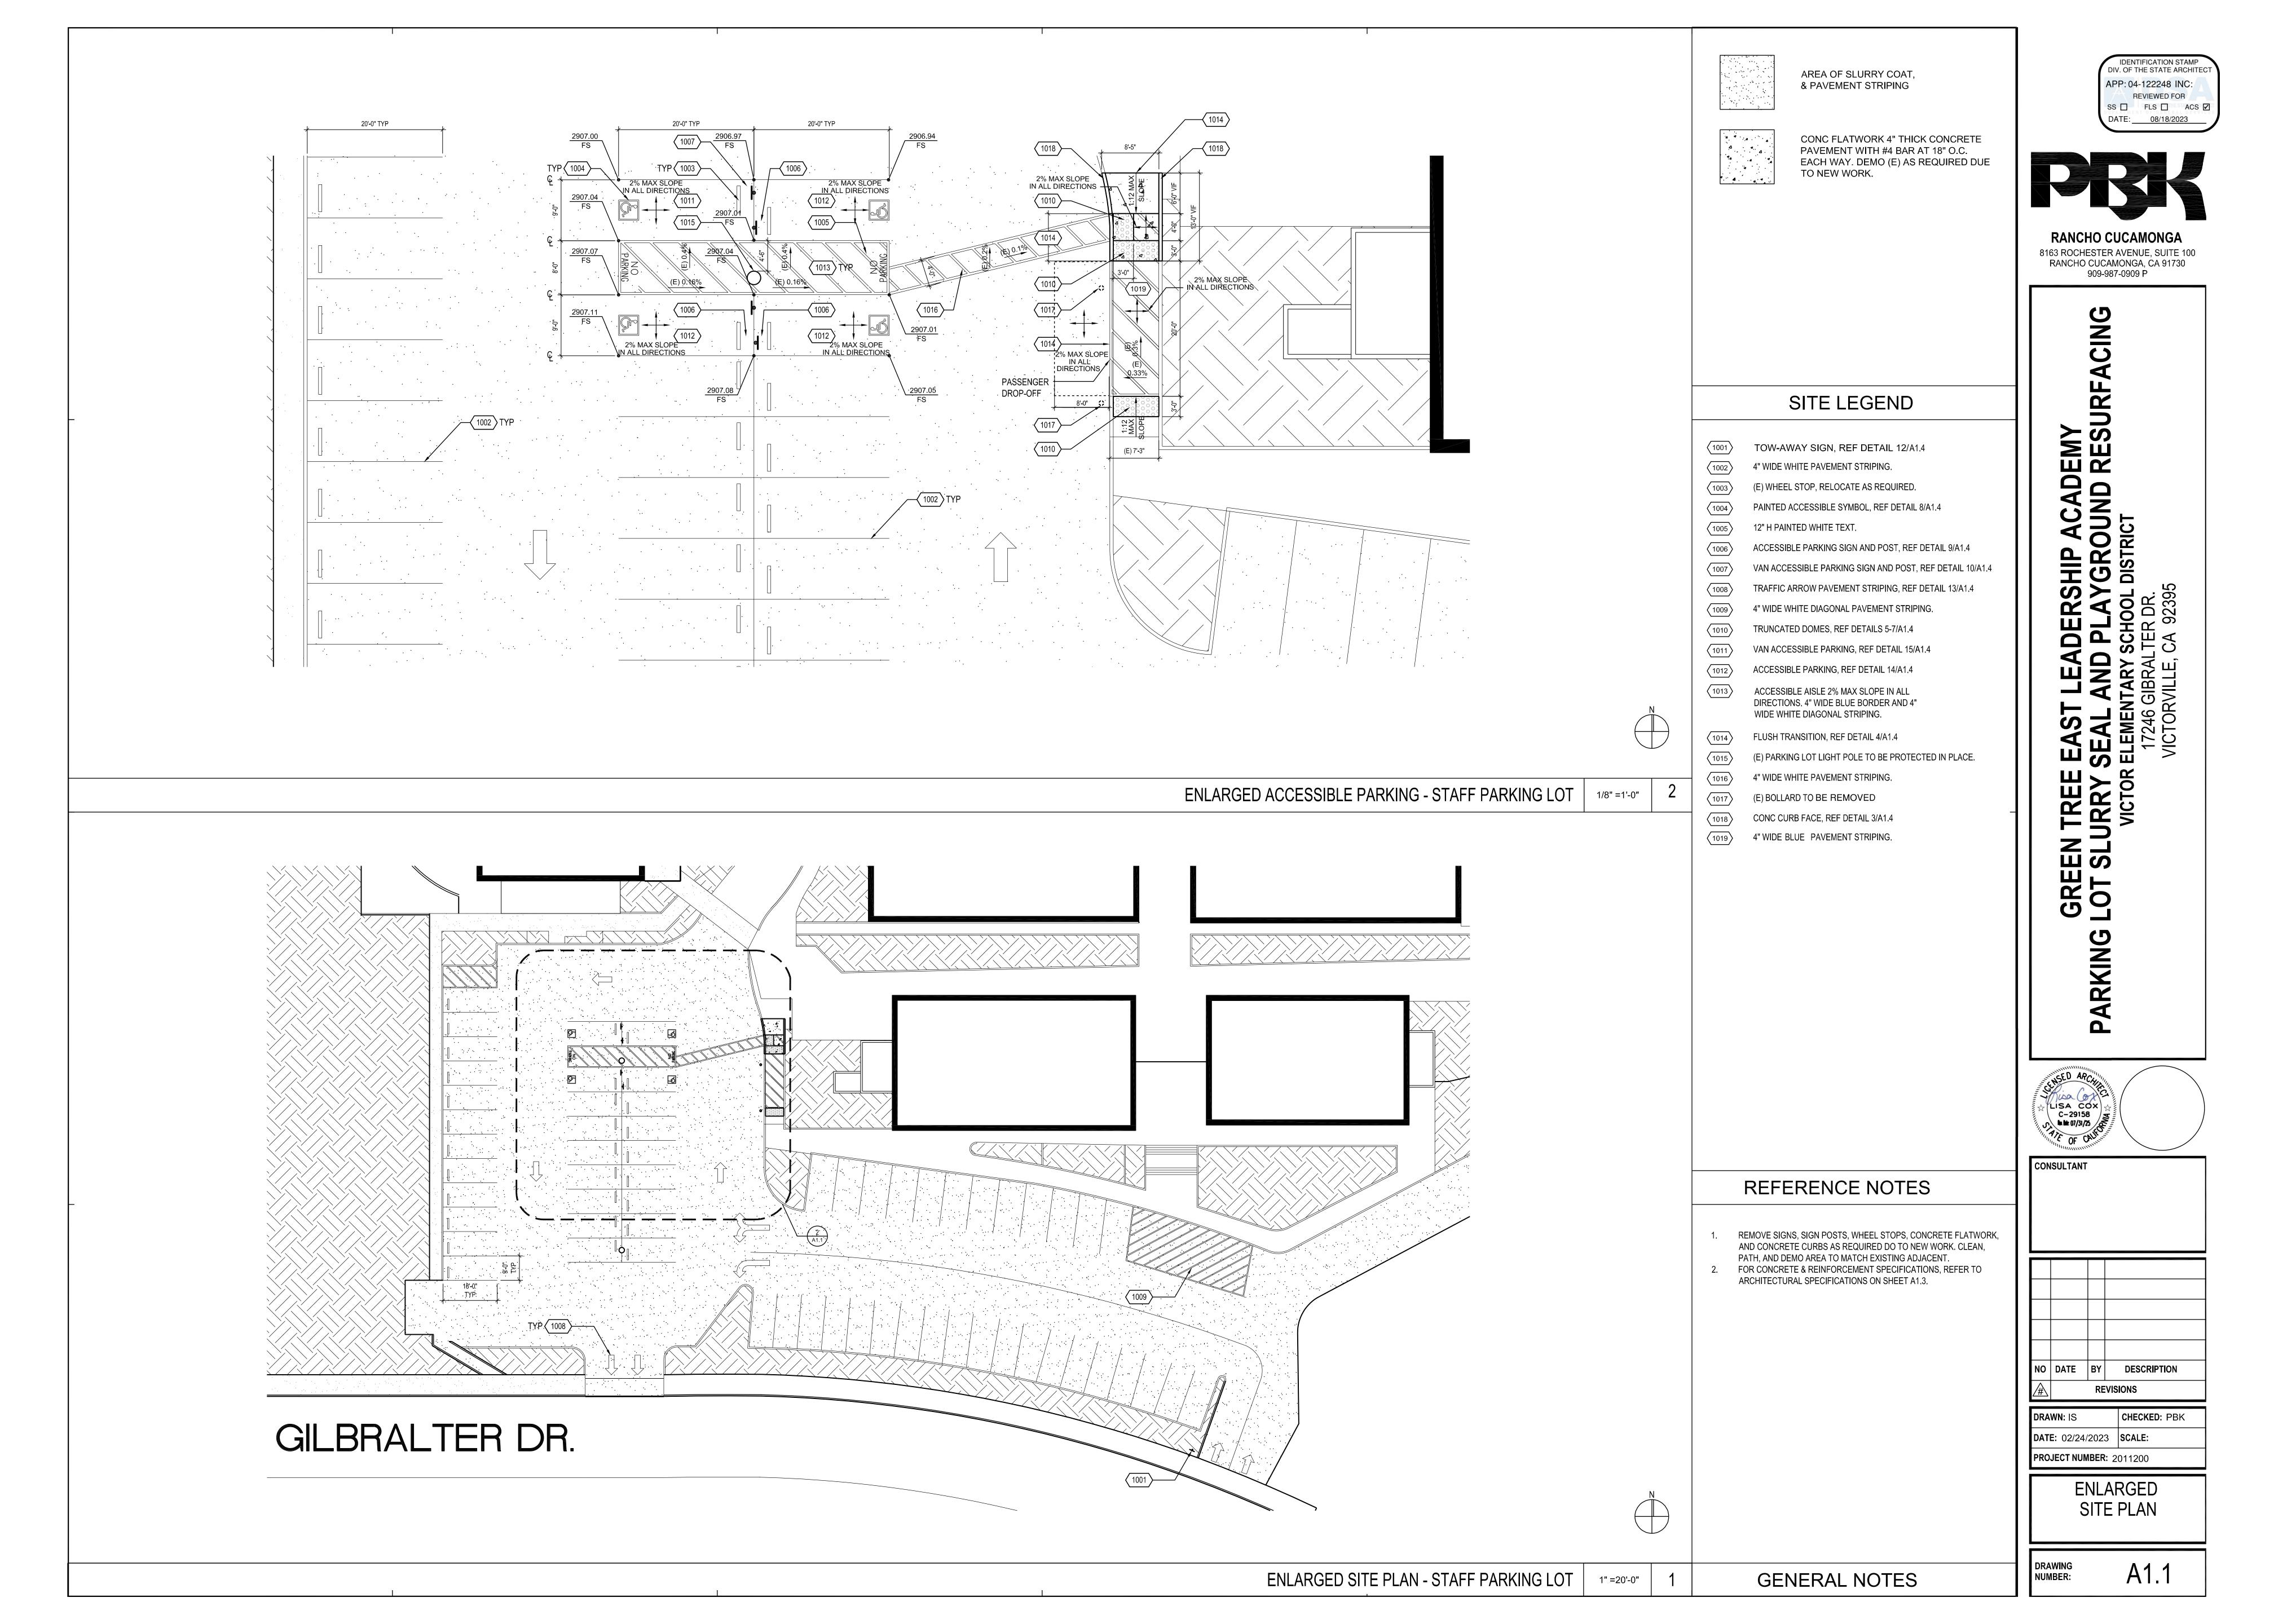

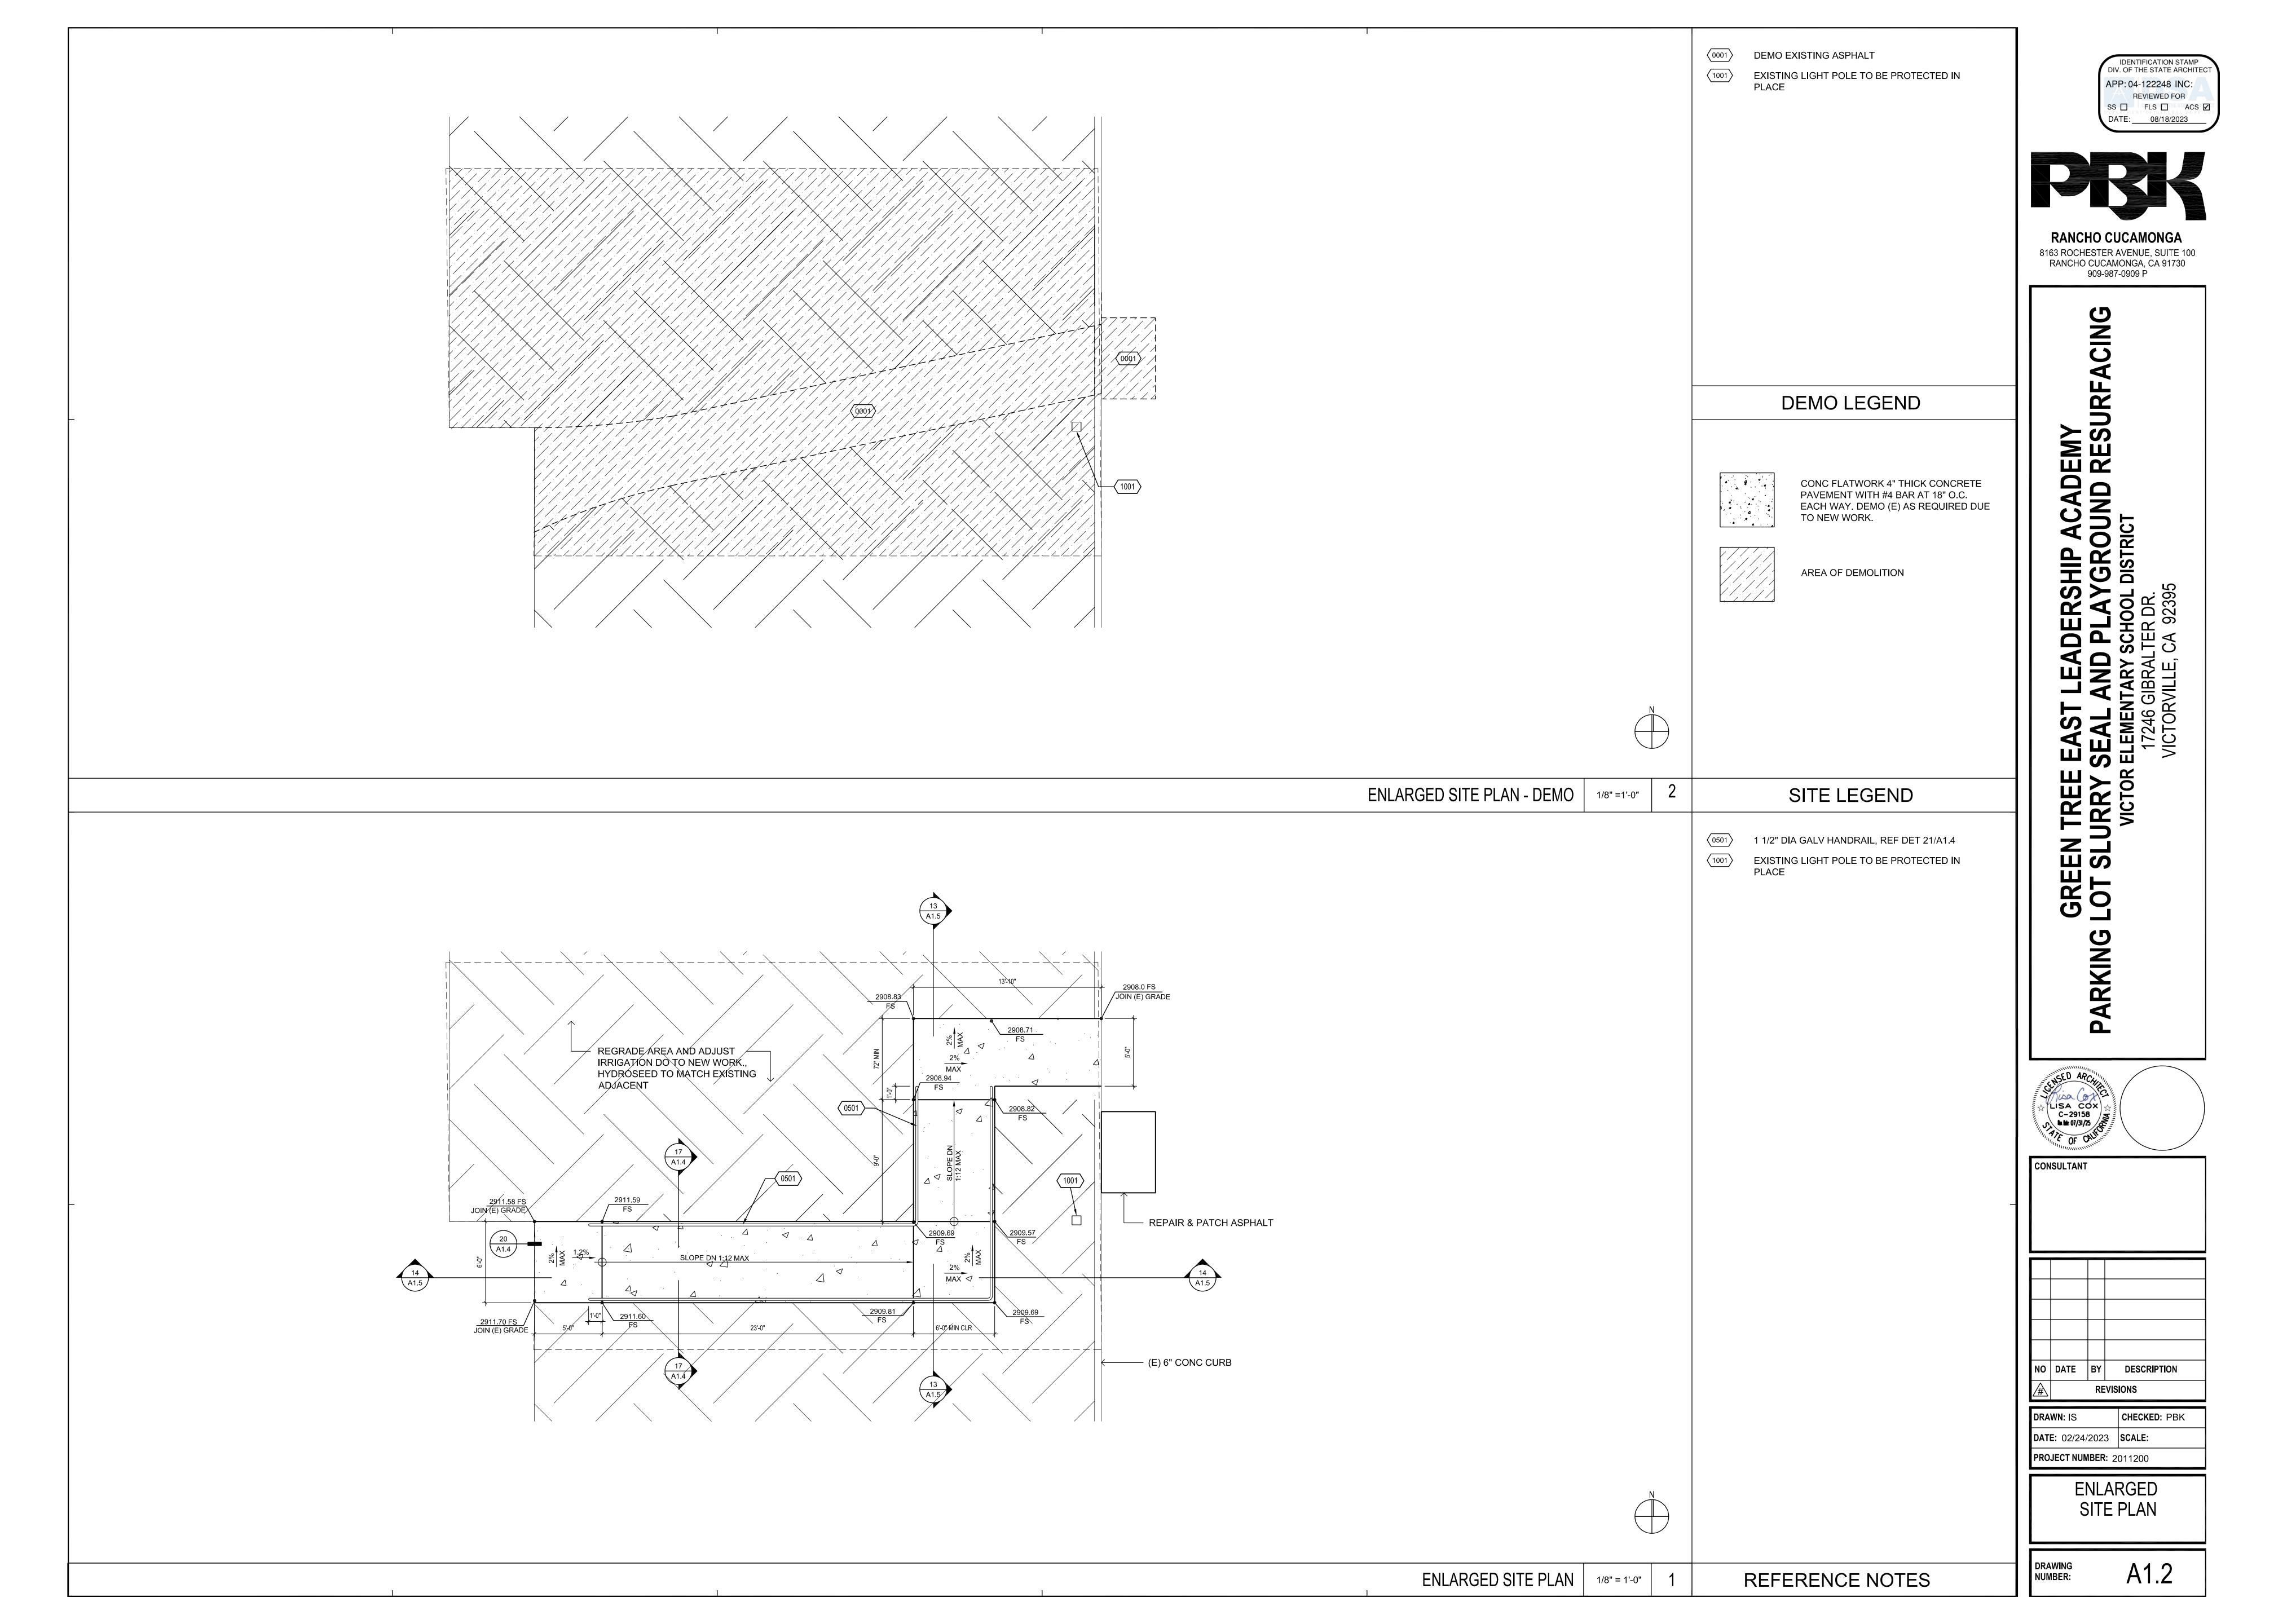

- REMOVE SIGNS, SIGN POSTS, WHEEL STOPS, CONCRETE FLATWORK, AND CONCRETE CURBS AS REQUIRED DO TO NEW WORK, CLEAN, PATH, AND DEMO AREA TO MATCH EXISTING ADJACENT
- DEMOLISH AND REPLACE CONCRETE FLATWORK TO NEAREST JOINT.

GENERAL NOTES

UNLESS NOTED OTHERWISE, REMOVE ANY ITEM INCLUDING BUT NOT LIMITED TO

STRUCTURE, HARDSCAPE, LANDSCAPE, RETAINING WALL, BOLLARDS, HANDRAILS, CURBS,

PARKING LOT LIGHTS ETC. FOR THE EXECUTION OF THE NEW PLAN. PROTECT ALL ADJACENT STRUCTURE, HARDSCAPE, LANDSCAPE AND ITEMS DURING CONSTRUCTION OR REPLACE

ADDITIONAL SCOPE OF WORK MAY BE REQUIRED BY OTHER DISCIPLINES, REFER TO OTHER

UTILITY AND IRRIGATION SYSTEM REMAIN IN WORKING CONDITION DURING AND AT THE END

ALL DEMOLITION WORK SHALL BE IN ACCORDANCE WITH THE ORDINANCES, REGULATIONS

AND APPLICABLE CODES OF THE CITY OF MENIFEE AS APPLICABLE AND WITH THE LATEST

DISCIPLINE'S DRAWINGS. SOME SITE CONDITIONS ARE NOT INDICATED IN THIS PLAN, ALL BIDDERS ARE REQUIRED TO VISIT THE SITE PRIOR TO BID. ENSURE THAT ALL EXISTING

EDITION OF THE STANDARD SPECIFICATIONS FOR PUBLIC WORKS CONSTRUCTION.

THE SITE AND BUILDING; AND SHALL BE SOLELY RESPONSIBLE FOR ANY DAMAGE TO

PROJECT ARCHITECT PRIOR TO PROCEEDING WITH THE WORK.

4. DUST SHALL BE CONTROLLED BY WATERING.

OTHER INVOLVED GOVERNING AGENCIES.

DESTROYED DURING DEMOLITION.

OUTSIDE OF THE DEMOLITION LIMITS.

NECESSARY DUE TO NEW WORK.

PRIOR TO COMMENCING WITH THE WORK IN QUESTION.

EXISTING IMPROVEMENTS (WHICH ARE TO REMAIN IN PLACE) RESULTING DIRECTLY OR INDIRECTLY FROM HIS OPERATIONS WHETHER OR NOT THOSE EXISTING IMPROVEMENTS ARE

IF ANY UNKNOWN SUB-SURFACE STRUCTURE IS ENCOUNTERED DURING DEMOLITION, IT SHALL

BE BROUGHT TO THE ATTENTION OF THE OWNER, THE SUPERVISING CIVIL ENGINEER AND THE

PRIOR TO COMMENCING ANY DEMOLITION WORK, THE CONTRACTOR SHALL MAKE PROVISIONS

THE REMOVAL OF HAZARDOUS MATERIALS IS NOT COVERED BY THESE PLANS. IN THE EVENT

THAT SOIL CONTAMINATED WITH HAZARDOUS MATERIALS OR ABANDONED UNDERGROUND

ASSESSMENT AND SEPARATE MITIGATION PLANS HAVE BEEN PREPARED BY OTHERS AND APPROVED BY THE OWNER, CITY OF MENIFEE OR AS APPLICABLE, COUNTY OF RIVERSIDE AND

THE LOCATION AND PROTECTION OF ALL UTILITIES AND SURVEY MONUMENTS OF EVERY

CONTRACTOR. THE CONTRACTOR SHALL BEAR THE TOTAL EXPENSE OF REPAIR OR

REPLACEMENT OF UTILITIES AND SURVEY MONUMENTS THAT HAVE BEEN DAMAGED OR

ALL ON-SITE IMPROVEMENTS WHICH ARE TO BE REMOVED OFF-SITE SHALL BE PROPERLY

THE CONTRACTOR SHALL CONTACT THE UNDERGROUND SERVICE ALERT, 48- HOURS IN

UTILITY LINES INDICATED AND ANY OTHER LINES OF RECORD NOT INDICATED ON THESE

ADVANCE OF THE COMMENCEMENT OF CONSTRUCTION FOR EXISTING UTILITY LOCATIONS. THE CONTRACTOR IS REQUIRED TO TAKE DUE PRECAUTIONARY MEASURES TO PROTECT THE

. ADEQUATE BARRICADES, LIGHTS, FLAGMEN, SIGNS AND OTHER SAFETY DEVICES SHALL BE PROVIDED AS SPECIFIED IN THE TRAFFIC MANUAL PUBLISHED BY THE STATE OF CALIFORNIA

EXISTING STUDENT HARDSCAPE AND WORK AREAS SHALL BE KEPT CLEAN OF ALL MATERIALS RESULTING FROM THE DEMOLITION OPERATIONS. THE STUDENT HARDSCAPE AND WORK AREAS SHALL BE CLEANED DAILY AS NECESSARY TO MAINTAIN SAFE ENVIRONMENT AT ALL TIMES.

2. ANY MODIFICATIONS OF, OR CHANGES IN DEMOLITION PLANS MUST BE APPROVED BY THE

S. CLEAN ADJACENT STRUCTURES AND IMPROVEMENTS OF DUST, DIRT AND DEBRIS CAUSED BY DEMOLITION OPERATIONS AS DIRECTED BY THE OWNER OR GOVERNING AUTHORITIES. RETURN ADJACENT AREAS TO EXISTING CONDITIONS PRIOR TO THE START OF WORK.

F. THE CONTRACTOR IS REQUIRED TO OBTAIN ALL NECESSARY PERMITS OR PERMISSION AND UTILITY DISCONNECTION PERMITS FROM THE CITY OF MENIFEE OR AS APPLICABLE AND UTILITY

5. ALL UNUSED UTILITIES, SEWER, WATER, GAS, TELEPHONE AND ELECTRIC SERVICES SHALL BE

DISCONNECTED AND CAPPED SHALL BE ACCORDING TO OWNER, CITY OF MENIFEE OR AS

7. DO NOT INTERRUPT ANY SERVICES OR DISRUPT THE ACTIVITIES OF THE EXISTING FACILITIES

8. REMOVE DEBRIS, RUBBISH AND OTHER MATERIALS RESULTING FROM THE DEMOLITION AND

EXISTING OR NEW ITEMS SHOWN ON THE ARCHITECTURAL DRAWINGS WHICH ARE INDICATED DIFFERENTLY ON ANY OF THE CONSULTING ENGINEERING DRAWINGS OR AS OCCURS IN THE FIELD SHALL IMMEDIATELY BE BROUGHT TO THE ARCHITECT'S ATTENTION FOR CLARIFICATION

DISCONNECTED AND CAPPED UNDERGROUND UNLESS NOTED OTHERWISE.

6. ALL UTILITIES, SEWER, WATER, GAS, TELEPHONE AND ELECTRIC SERVICES TO BE

APPLICABLE AND UTILITY COMPANY REQUIREMENTS, UNLESS OTHERWISE NOTED.

SITE CLEARING OPERATIONS FROM THE SITE AND DISPOSE OF IN A LEGAL MANNER.

0. ADJUST EXISTING VAULT BOXES, CATCH BASINS, CONTROL BOX TO NEW GRADE AS

GENERAL DEMO NOTES

OF RIVERSIDE, STATE AND FEDERAL GUIDELINES AND REGULATIONS.

HANDLED AND DISPOSED OF IN COMPLIANCE WITH CITY OF MENIFEE AS APPLICABLE, COUNTY

NATURE. WHETHER OR NOT INDICATED ON THESE PLANS, ARE THE RESPONSIBILITY OF THE

FOR AN ADEQUATE AND CONTINUOUS SOURCE OF WATER DURING DEMOLITION AND

STORAGE TANK IS DISCOVERED, DEMOLITION WORK SHALL BE STOPPED UNTIL A SITE

GENERAL:

INDICATED ON THIS PLAN.

- ALL CEMENT SHALL CONFORM AT ASTM C-150, TYPE I OR II FIND AND COARSE AGGREGATE SHALL CONFORM TO ASTM C-33 CONCRETE SHALL HAVE THE FOLLOWING MINIMUM 28 DAY STRENGTH: SIDEWALKS, CURBS - 2500 PSI
 - FOOTING 3500 PSI 4. CONCRETE MIXES SHALL BE PREPARED BY A CA REGISTERED CIVIL ENGINEER, AND REVIEWED BY THE APPROVED TESTING AGENCY AND APPROVED BY AOR.
- 5. PLACING OF ALL CONCRETE SHALL BE INSPECTED BY THE PROJECT INSPECTOR. INSPECTOR TO VERITY THAT REINFORCING STEEL IS SECURELY SUPPORTED IN PLACE DURING THE POUR.
- 6. DOWELS, REINFORCING STEEL, INSERTS, ETC SHALL BE SECURELY TIED IN PLACE PRIOR TO POURING CONCRETE.
- 7. PROVIDE 3/4" CHAMFER ON ALL EXPOSED CONCRETE CORNERS. 8. ALL CONCRETE SHALL BE VIBRATED IN PLACE DURING PLACING OF CONCRETE.
- 9. THE WOOD FORM WILL DEFLECT WHILE CONCRETE IS BEING PLACE ON IT. THIS WILL RESULT IN THE NEED TO ADJUST THE SCREEDS AFTER THE CONCRETE HAS BEEN PLACED TO PRODUCE A LEVEL CONCRETE SURFACE. ALSO, THERE WILL BE ADDITIONAL REQUIRED, WHICH IS TO BE ANTICIPATED. AND AT NO REQUEST FOR EXTRA COST WILL BE CONSIDERED.
- 10. GROUT SHALL BE 1:3:2 PORTLAND CEMENT TO SEA TO PEA GRAVEL WITH A MINIMUM 28 DAY STRENGTH OF 7000 PSI. NON-SHRINK GROUT.

- ALL REINFORCING SHALL CONFORM TO ASTM A-615 SPECIFICATION, GRADE 60. WELDED BAR SHALL BE ASTM A-706.
- REINFORCING BARS SHALL BE SPLICED AND BENT IN STRICT ACCORDANCE WITH C.R.S.I. PUBLICATIONS. NO KNIKS ALLOWED. AL BARS SHALL BE CLEANED PRIOR TO CONCRETE PLACEMENT.


REINFORCING STEEL SHALL BE SECURELY TIED IN PLACE PRIOR TO

INSPECTION AND PLACING OF CONCRETE. DO NOT PLACE REINFORCING

RESILIENT PLAY AREA SURFACING

IN WET CONCRETE.


- PROVIDE A COMPLETE INSTALLATION OF POURED-IN-PLACE SURFACING
- DESIGNED FOR INSTALLATION AROUND PLAYGROUND EQUIPMENT. 2. THE SYSTEM SHALL BE COMPRISED OF A DUAL-LAYER MIXTURE OF STRAND AND GRANULE RUBBER COMPOUNDS BONDED BY POLYURETHANE. EQUAL TO TOTTURF BY ROBERTSON INDUSTRIES.
- POURED-IN-PLACE RESILIENT SURFACING OF TWO LAYERS. CUSHION COURSE AND WEATHER RESISTANT WEARING COURSE. CUSHION COURSE OF 100 PERCENT RECYCLED SHREDDED AND STYRENE BUTADIENE RUBBER BONDED BY POLYURETHANE 3 INCH THICK. WEARING COURSE OF BOND OF RECYCLED ETHYLENE PROPYLENE DIENE MONOMER (EPDM) PARTICLES MEETING ASTM D415 BONDED BY POLYURETHANE 1/2 INCH THICK. BINDER IS SINGLE COMPONENT POLYURETHANE PREPOLYMER. BITUMINOUS CONCRETE SUB-BASE OF 3 INCH THICK.
- SYSTEM PERFORMANCE REQUIREMENTS: A. SYSTEM SHALL MEET IMPACT ATTENUATION PER ASTM DESIGNATION
- B. PLAYGROUND SURFACE MUST MEET ACCESSIBILITY REQUIREMENTS OF ASTM F1951, CBC SECTION 11B-1008 AND TABLE 11B-240.2.1.2 C. GROUND SURFACES ON ACCESSIBLE ROUTES, CLEAR FLOOR OR GROUND SPACES, AND TURNING SPACES SHALL COMPLY WITH CBC SECTION 11B-1008.2.6: FOR ACCESSIBILITY; GROUND SURFACES SHALL COMPLY WITH ASTM F 1951 AND SHALL BE INSPECTED AND MAINTAINED REGULARLY AND FREQUENTLY TO ENSURE CONTINUED COMPLIANCE. GROUND SURFACES WITHIN USE ZONES SHALL COMPLY WITH ASTM
- TOLERANCES: FINISHED WORK SHALL VARY NO MORE THAN 3/16 INCH IN 10 FEET WHEN MEASURED WITH A STRAIGHT EDGE
- INSTALLATION CERTIFICATION AT COMPLETION OF THE WORK, PROVIDE FINIAL INSPECTION CERTIFICATION BY A CERTIFIED PLAYGROUND SAFETY INSPECTOR THAT INSTALLATION OF MATERIAL MEETS THE REQUIREMENTS OF THE CPSC
- DASHED OUTLINE AROUND PLAYGROUND DEMONSTRATES GROUND SURFACES WITHIN USE ZONES. GROUND SURFACES WITHIN USE ZONES TO COMPLY WITH ASTM F1292, (1999 EDITION OR 2004 EDITION). (PER

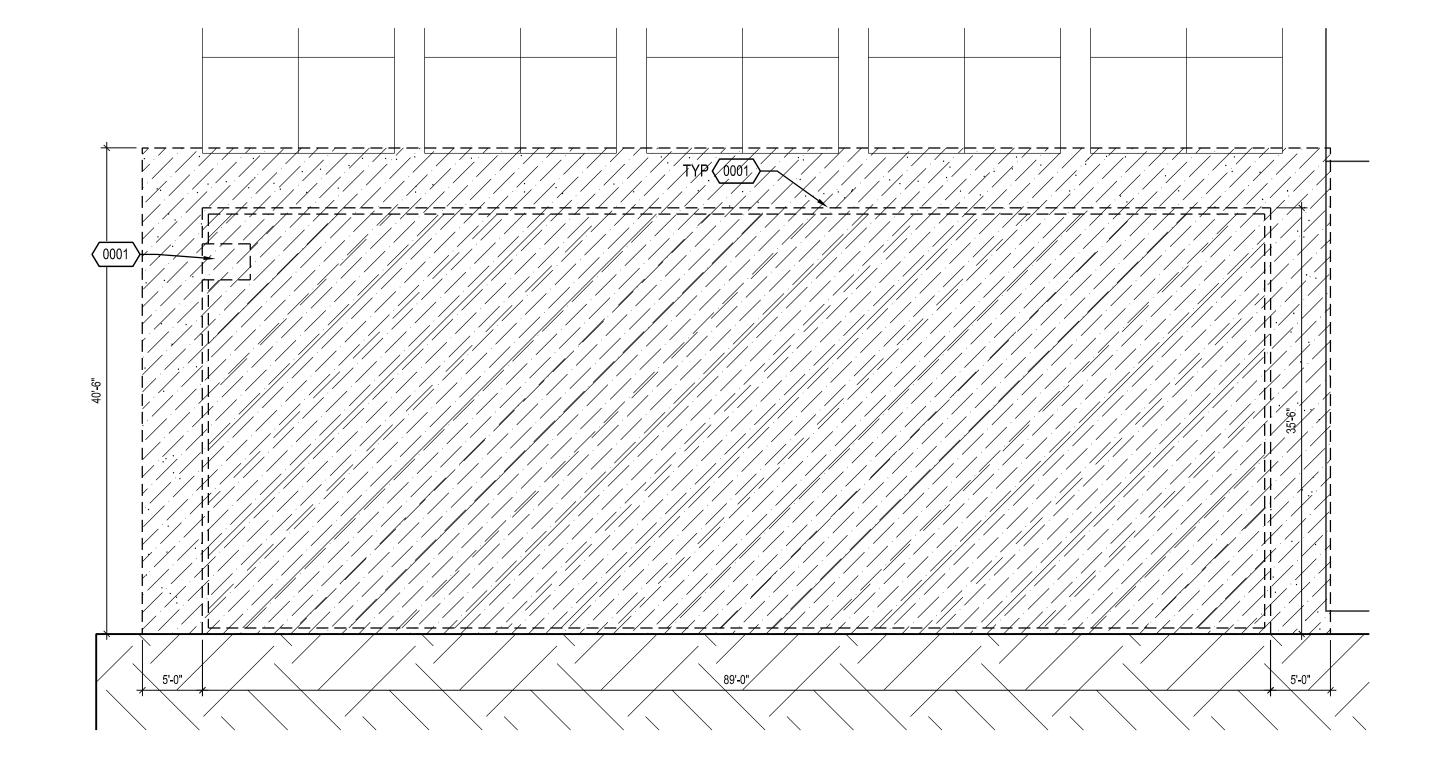


— 30X48 TRANSFER STATION

16 A1.4


TYP (1001)

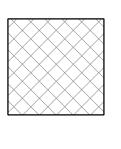

RESILIENT PLAY SURFACING AREA

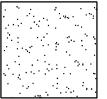

ASPHALT PAVING TO MATCH EXISTING SECTION ADAJCENT

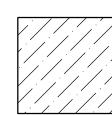

AREA OF DEMOLITION

IDENTIFICATION STAMP

DIV. OF THE STATE ARCHITEC

REVIEWED FOR

SS | FLS | ACS |

APP: 04-122248 INC:

DATE: 08/18/2023

8163 ROCHESTER AVENUE, SUITE 100 RANCHO CUCAMONGA, CA 91730

909-987-0909 P

EMY RESURF


HIP ACADI GROUND F

EA

GREEN TREE OT SLURRY

SITE LEGEND

- DEMO 6" CONCRETE CURB AND RAMP
- (1001) NEW 6" X 18" CONCRETE CURB
- (1002) NEW RESILIENT PLAY SURFACING AREA
- (1003) (E) PLAY APPARATUS B
- (1004) PLAY APPARATUS A (OFOI)
- 4" PVC PERFORATED PIPE, SDR 35 TRENCH DRAIN, CONNECT TO (E) STORM DRAIN LINE
- PROVIDE MISSING COURT STRIPING DUE TO NEW WORK

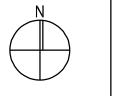


REFERENCE NOTES


Age Group: 5-12			
Elevated Play Activities Total:	7		
ted Play Activities Accessible By Transfer:	7	Req'd:	4
vated Play Activities Accessible By Ramp:	0	Req'd:	0
Ground Level Activity Type:	2	Req'd:	2
Ground Level Quantity:	6	Req'd:	2

Description	Elevation Access		Type of Play	Qty
BACKTRACK CLIMBER (6'6" DECK)	Elevated	Transfer	CLIMBER	1
CABLE ROPE OVERHEAD CLIMBER (ONLY)	Elevated	Transfer	UPPER_BODY_CLIMBER	1
CROSSWAY CLIMBER LARGE	Elevated	Transfer	CLIMBER	1
GROOVE II SLIDE VORTEX (6' & 6'6" DECK)	Elevated	Transfer	SLIDE	1
GROOVE II SLIDE VORTEX (6' & 6'6" DECK)	Elevated	Transfer	SLIDE	1
ORBIT CLIMBER (ONLY)	Elevated	Transfer	UPPER_BODY_CLIMBER	1
VERTICAL CLIMBING WALL (6'6" DECK)	Elevated	Transfer	CLIMBER	1
CHINNING BAR ONLY	Ground	Ground	UPPER_BODY_CLIMBER	1
DIP STATION	Ground	Ground	UPPER_BODY_CLIMBER	1
SWG FRAME	Ground	Ground	SWING	4

PLAY APPARATUS ANALYSIS

LISA COX Mark 07/31/25

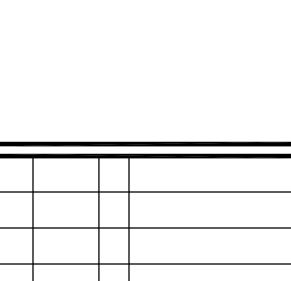

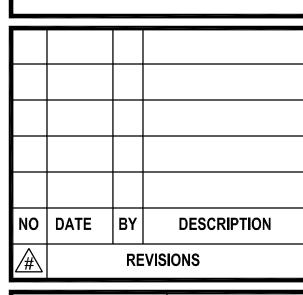

DRAWN: IS	CHECKED: PBK			
DATE : 02/24/2023	SCALE:			
PROJECT NUMBER: 2011200				

CONSULTANT

ENLARGED SITE PLAN

A1.3



NOTE: PROVIDE 2" WIDE STRIPE OF CONTRASTING COLOR AT EACH STEP

1018

(E) 0.26%

ARCHITECTURAL SPECIFICATION

ENLARGED SITE PLAN - PLAYGROUND

ENLARGED DEMO SITE PLAN - PLAYGROUND

(E) 0.26%

1/8"=1'-0"

16 A1.4

NUMBER:

